



P Max 250 kg/m²

Name-Name-Nom-Titel 4457221	Page-Seite-Page-Sida 1
View-Aussicht-Vue-Utsikt 3D	
Material-Material-Matériel-Material 44x135	Scale-Maßstab-Echelle-Skala 1:30
Drafter-Zeichner-Rédacteur-Föredragande EJ	Date-Datum-Date-Datum 26.04.2022

H = 0.150 m
TOTAL: 9.42 m²

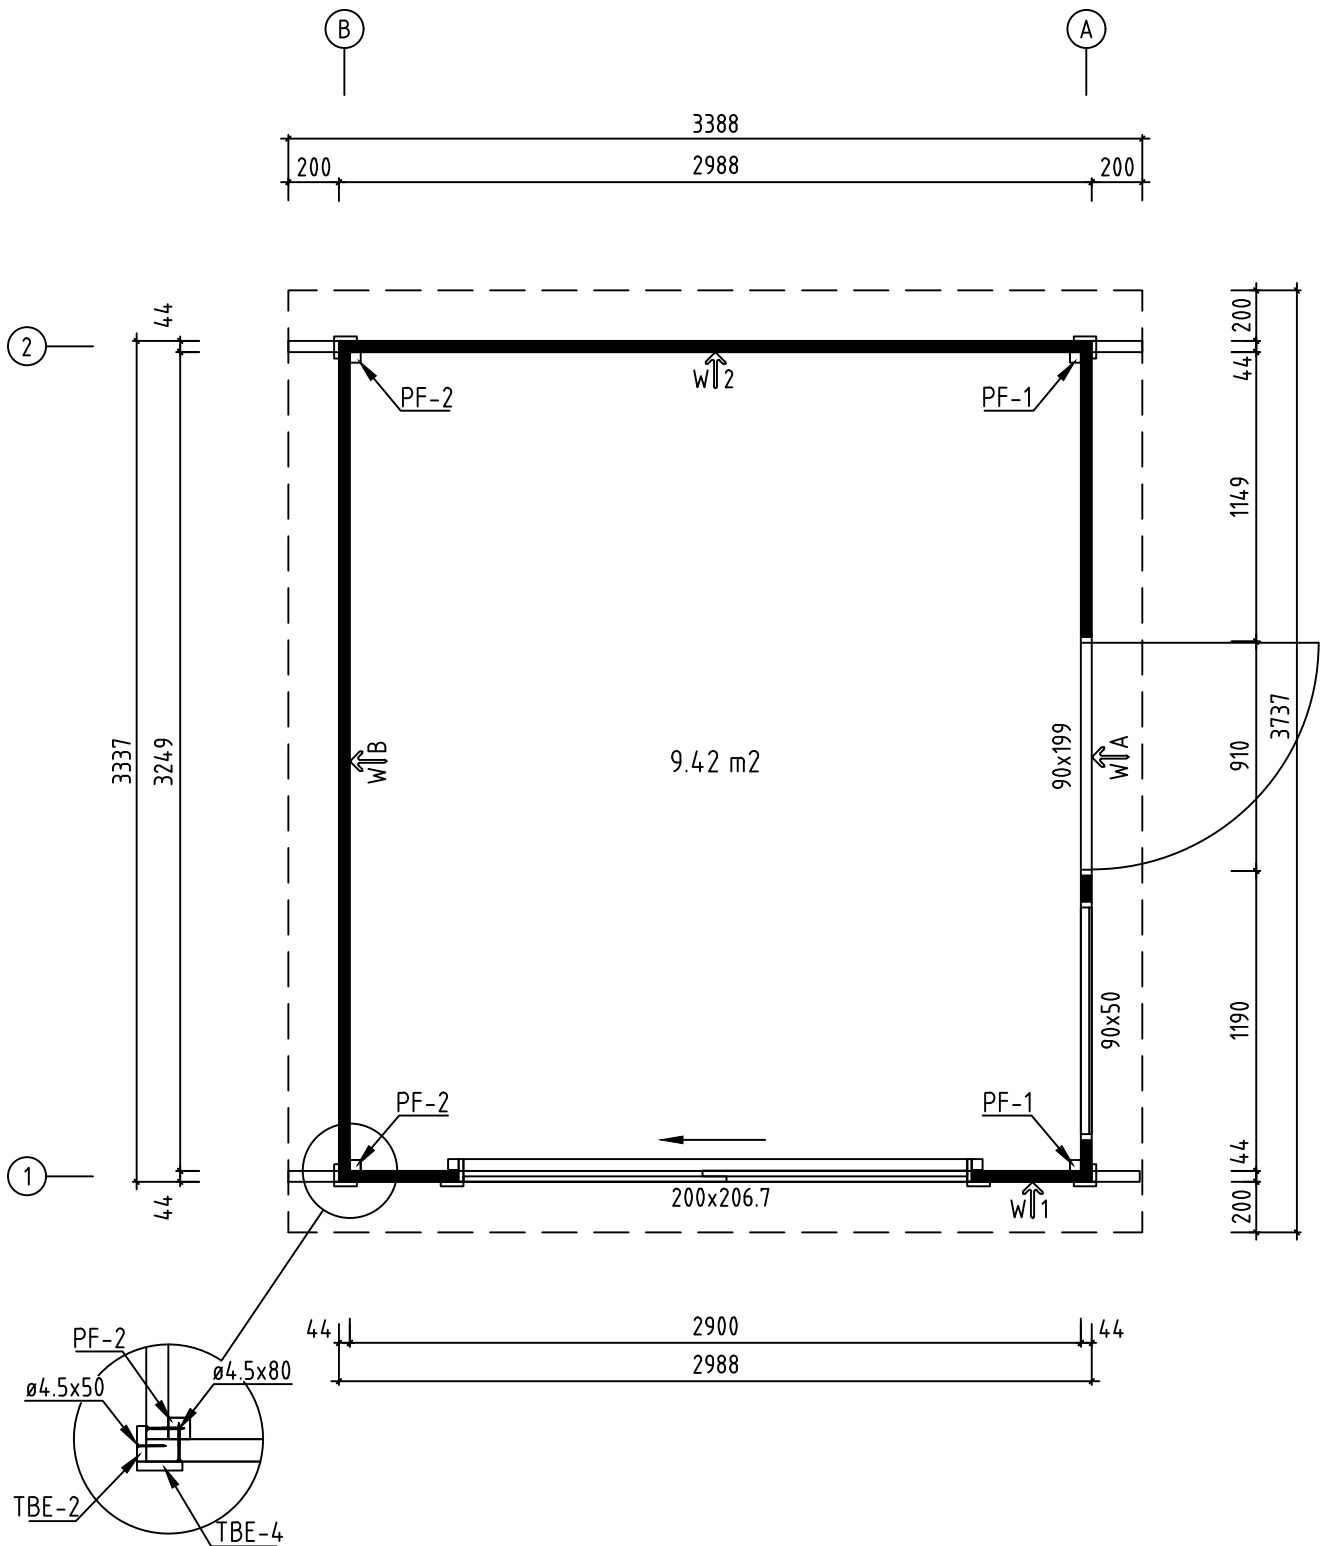

Name-Name-Nom-Titel 4457221	Page-Seite-Page-Sida 2
View-Aussicht-Vue-Utsikt GROUNDPLAN - GRUNDPLAN - PLAN DE MASSE - PLANRITNING	
Material-Material-Matériel-Material 44 x 135	Scale-Maßstab-Echelle-Skala 1:30
Drafter-Zeichner-Rédacteur-Föredragande EJ	Date-Datum-Date-Datum 26.04.2022

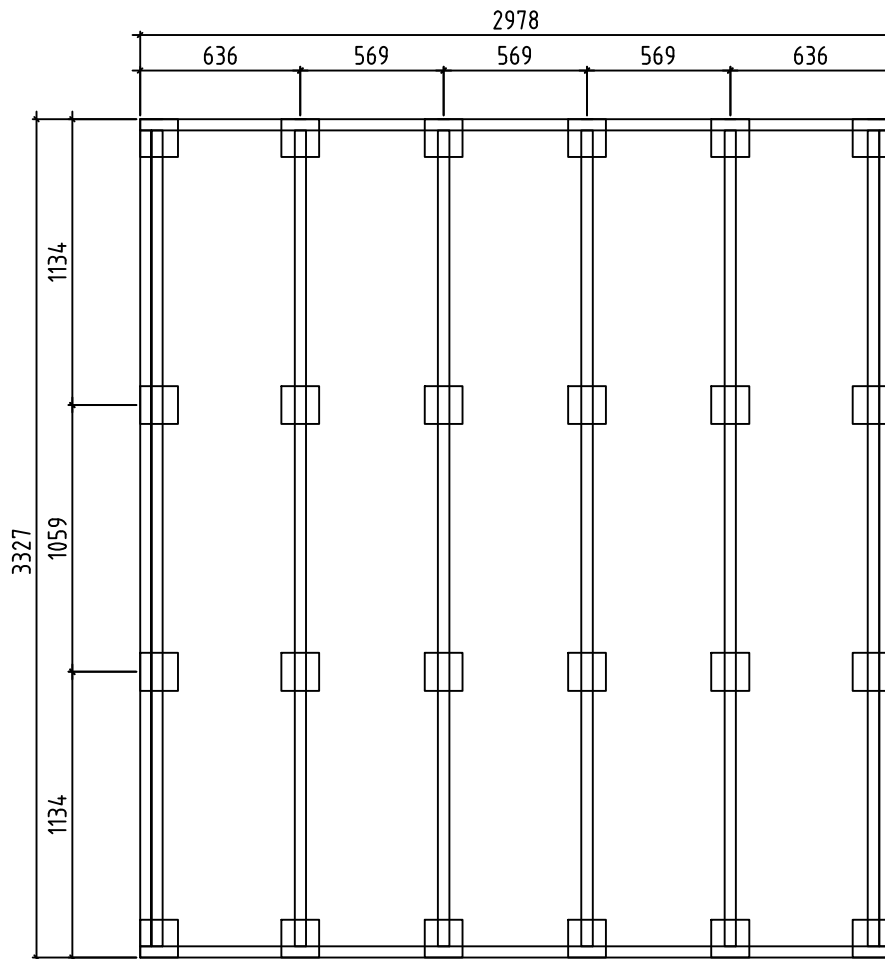


Detta är ett förslag för hur man kan placera plintarna (100- 200 mm i diameter) för golvbjälklaget. Golvbjälkarna är med i byggsatsen, men inte plintarna. Använder man exempelvis 500-600mm långa murblock så kan man halvera antalet punkter. Lägg fuktskyddande papp mellan betong och trä

Tämä on ehdotus siitä, miten (100-200 mm läpimittaiset) jalat voidaan sijoittaa alapohjaa varten. Lattiapalkit ovat rakennussarjassa, mutta jalkoja ei ole. Kun käytetään esimerkiksi 500-600 mm pitkiä harkkoja, voidaan pisteiden määrä puolittaa. Aseta betonin ja puun väliin kosteudelta suojaava pahvi

A proposal for placing plinths (100-200 mm in diameter) for floor beams. Floor beams are provided in the kit but plinths are not included. For example, by using 500-600 mm long masonry units, one can reduce the number of points 50%. Place roofing felt between the concrete and wood to protect from moisture

Name-Name-Nom-Titel 4457221	Page-Seite-Page-Sida 3
View-Aussicht-Vue-Utsikt FOUNDATION PLAN - PLINT PLAN	
Material-Material-Matériel-Material 44x135	Scale-Maßstab-Echelle-Skala 1:30
Drafter-Zeichner-Rédacteur-Föredragande EJ	Date-Datum-Date-Datum 26.04.2022



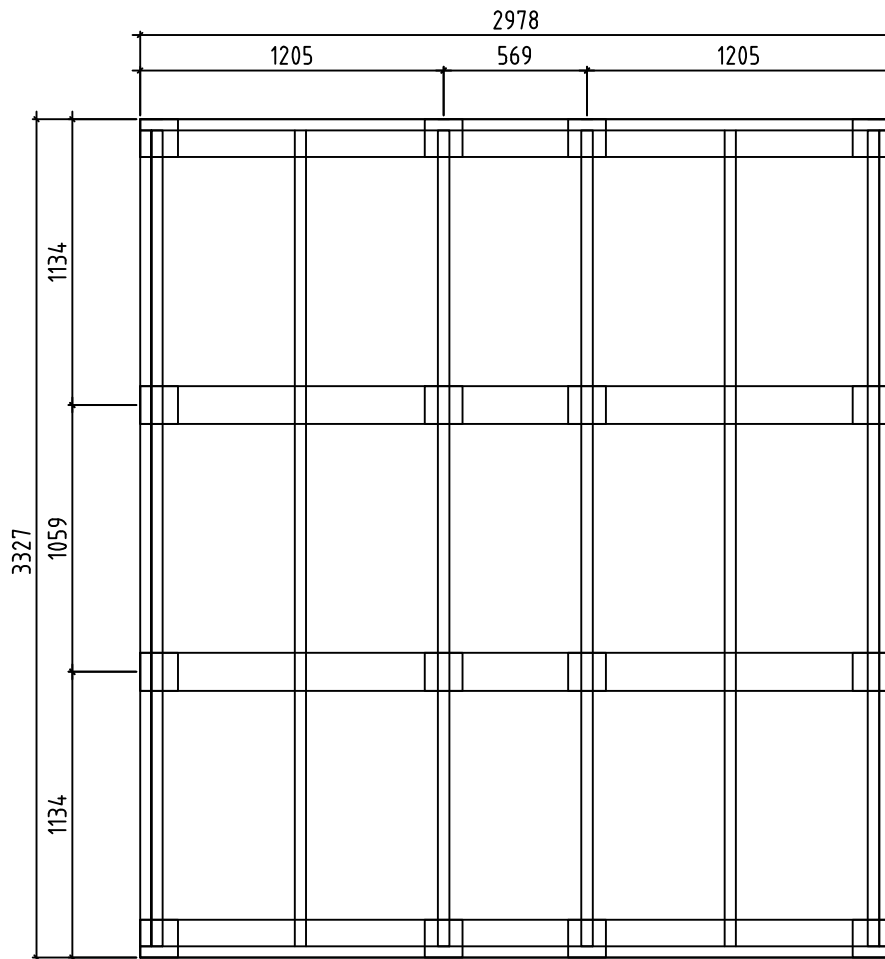


Förslag på alternativ plintplan med bärlinor och plintar. Bärlinor 45x 95 eller 45x 120 och plintar ca 100- 200 mm i diameter. (Bärlinor och plintar ingår ej i leveransen). Används exempelvis murblock, (ingår ej i leveransen) istället för plintar, kan man lägga bärlinorna platt mot dessa och på det sättet minska höjden på konstruktionen. I denna konstruktion kan man dessutom lägga en "boardskiva" mellan bärlinorna och golvbjälkarna och på det sättet bära upp bjälklagsisoleringen. Lagg fuktskyddande papp mellan betong och trä

Ehdotus vaihtoehtoisesta jalustasta kannattajilla ja jaloilla. Kannattajat 45x95 tai 45x120 ja jalat läpimitaltaan n. 100-200 mm (kannattajia ja jalkoja ei ole toimituksessa). Käytettäessä esimerkiksi harkkoja (ei kuulu toimitukseen) jalkojen sijasta, voi kannattajat asettaa lappeelleen niitä vasten ja sillä tavoin vähentää rakenteen korkeutta. Tässä rakenteessa voi lisäksi asettaa levyn kannattajien ja lattiapalkkien väliin ja sillä tavoin kannattaa alapohjan eristystä. Aseta betonin ja puun väliin kosteudelta suojaava pahvi

A proposal for alternative plinth beam layout plan. Plinth beams 45x95 or 45x120 and plinths ca 100-200 mm in diameter (plinth beams and plinths are not included in the kit). For example, by using masonry units (not included in the kit) instead of plinths, one can lay plinth beams flat against the masonry units and in that way reduce the height of the structure. In this construction one can also add "plywood board" between plinth beams. Place roofing felt between the concrete and wood to protect from moisture


Name-Name-Nom-Titel 4457221	Page-Seite-Page-Sida 4
View-Aussicht-Vue-Utsikt FOUNDATION PLAN - PLINT PLAN	
Material-Material-Matériel-Material 44x135	Scale-Maßstab-Echelle-Skala 1:30
Drafter-Zeichner-Rédacteur-Föredragande EJ	Date-Datum-Date-Datum 26.04.2022

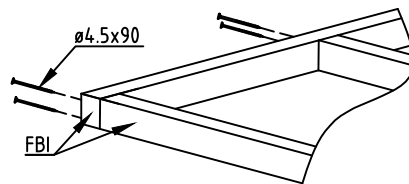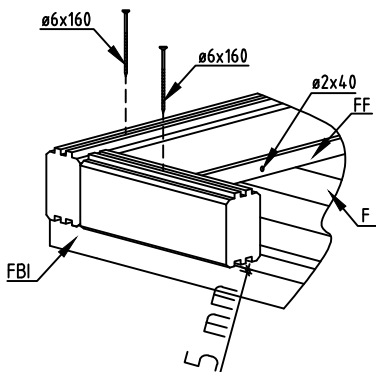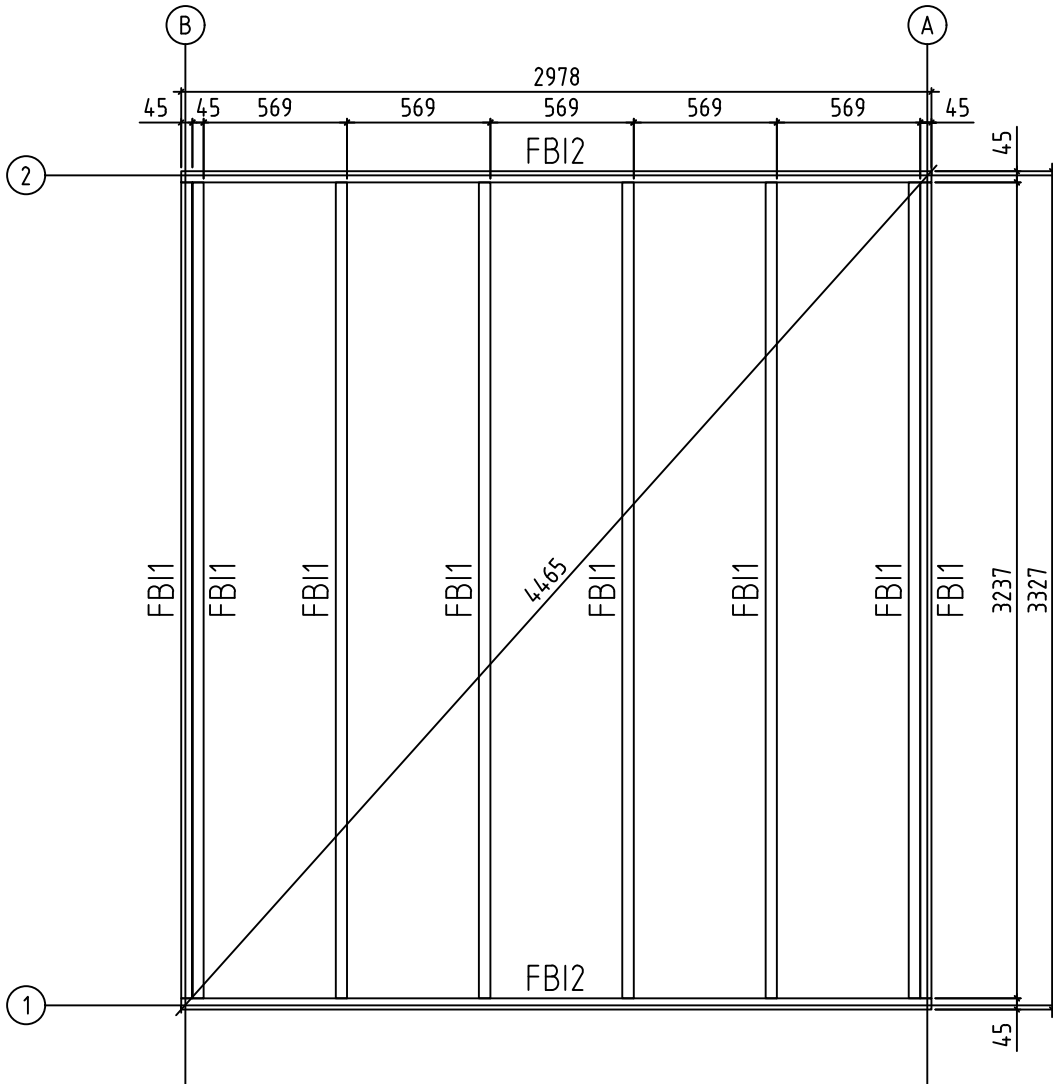


Name-Name-Nom-Titel 4457221	Page-Seite-Page-Sida 5
View-Aussicht-Vue-Utsikt FOUNDATION - FUNDAMENT - FONDATION - GOLVBÄLKAR	
Material-Material-Mat�riel-Material 44x135	Scale-Ma�stab-Echelle-Skala 1:30
Drafter-Zeichner-R�dacteur-F�redragande EJ	Date-Datum-Date-Datum 26.04.2022

ALU op.1

Assemble floorboards before door aluminium profiles
Montieren Sie Fußbodenbretter vor der Tür Aluminiumprofile
Assembler les lames de plancher avant les profilés en aluminium de la porte
Montera golvbrädor innan montering av aluminium dörr profiler






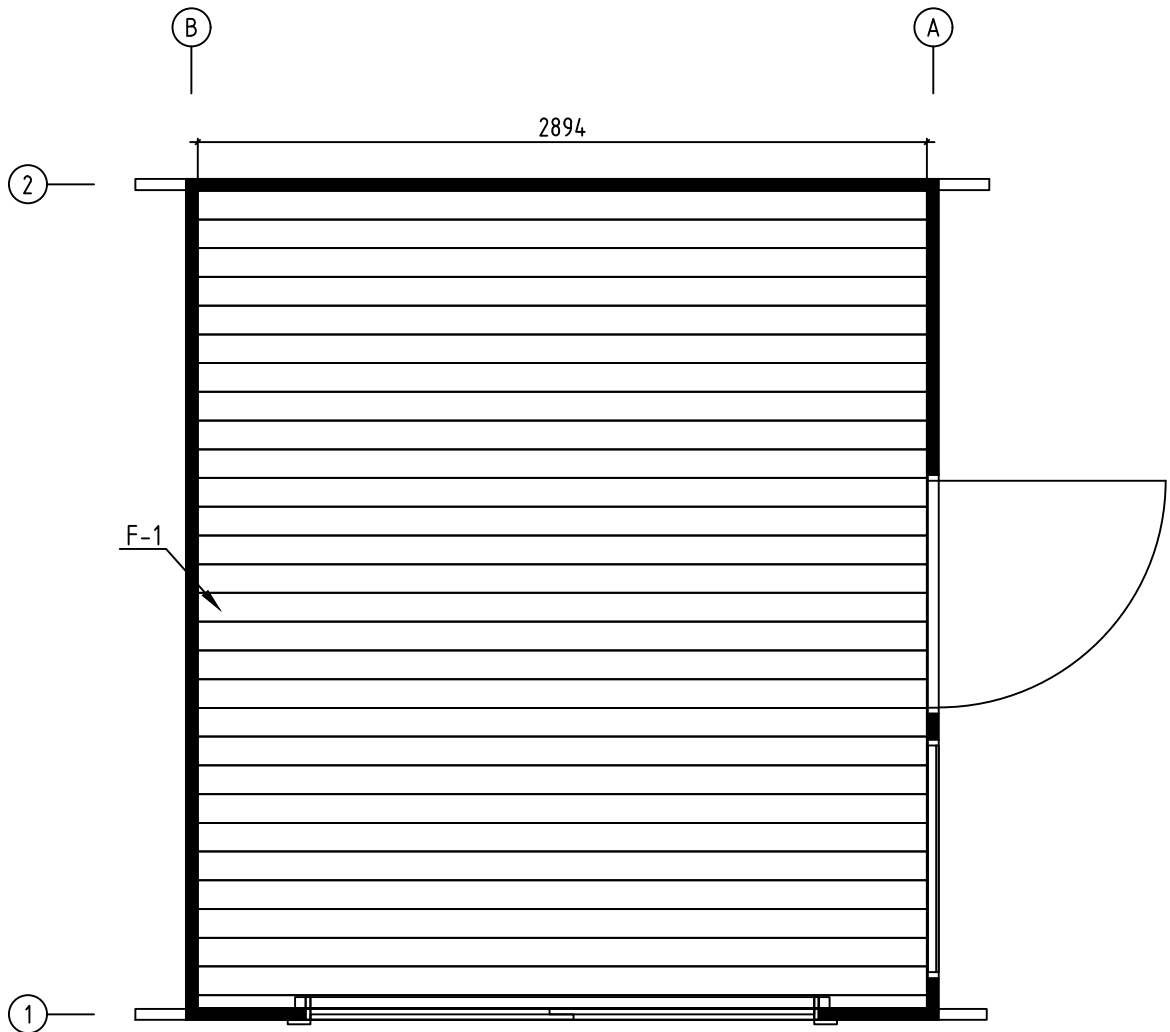


Name-Name-Nom-Titel 4457221	Page-Seite-Page-Sida 6
View-Aussicht-Vue-Utsikt FLOOR BOARDS-FUSSBODENBRETTER-LAME DE PLANCHER-GOLVBRÄDOR	
Material-Material-Matériel-Material 44x135	Scale-Maßstab-Echelle-Skala 1:30
Drafter-Zeichner-Rédacteur-Föredragande EJ	Date-Datum-Date-Datum 26.04.2022

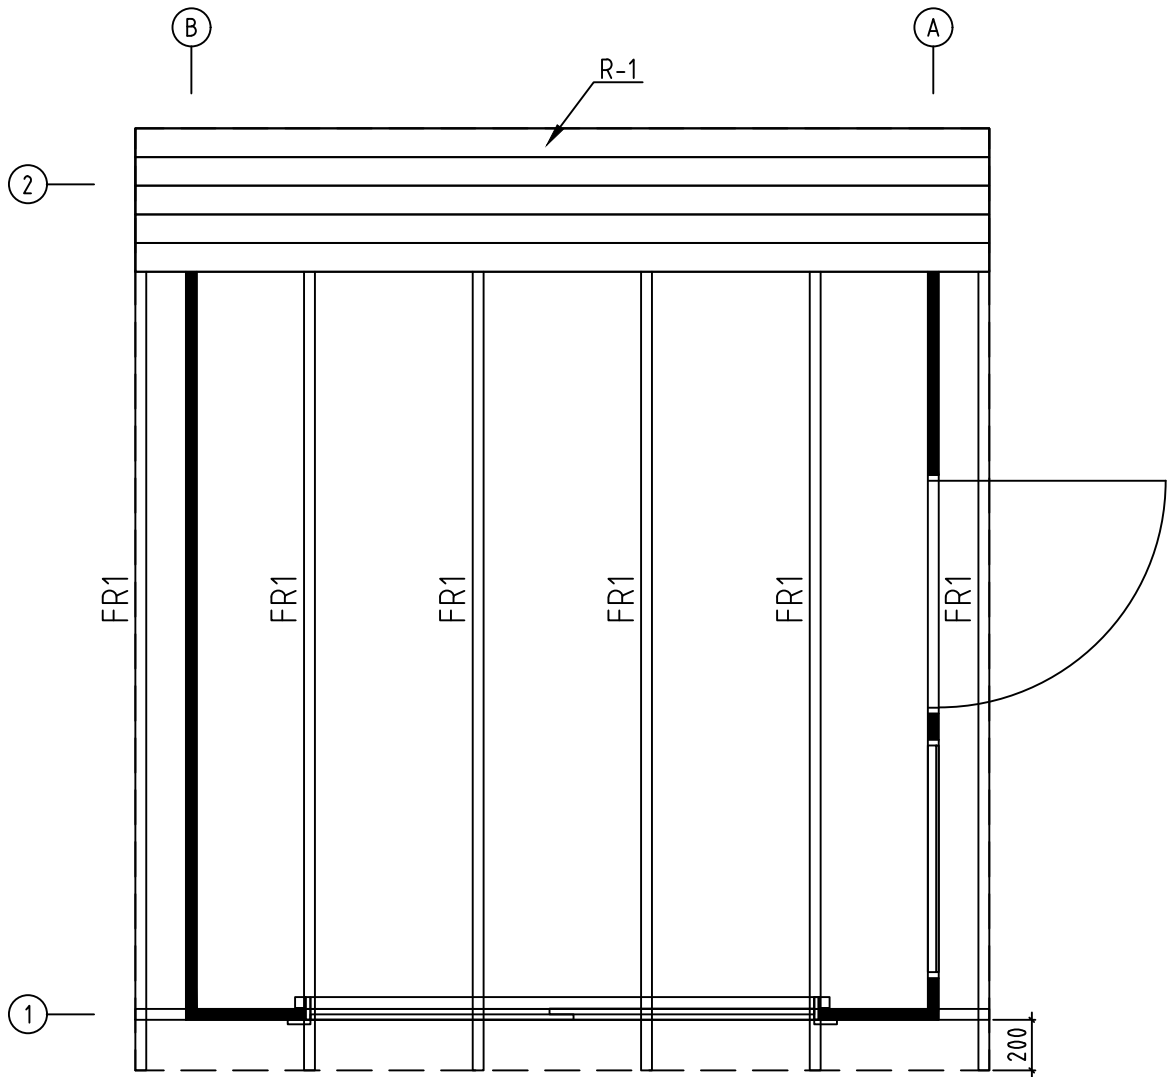


P Max 250 kg/m²

Name-Name-Nom-Titel 4457221	Page-Seite-Page-Sida 7
View-Aussicht-Vue-Utsikt RAFTERS PLAN-DACHSPARREN-PLAN DE CHEVRON-PLAN ÖVER TAKSPARRE	Scale-Maßstab-Echelle-Skala 1:30
Material-Material-Matériel-Material 44x135	Date-Datum-Date-Datum 26.04.2022
Drafter-Zeichner-Rédacteur-Föredragande EJ	

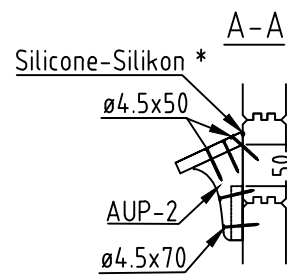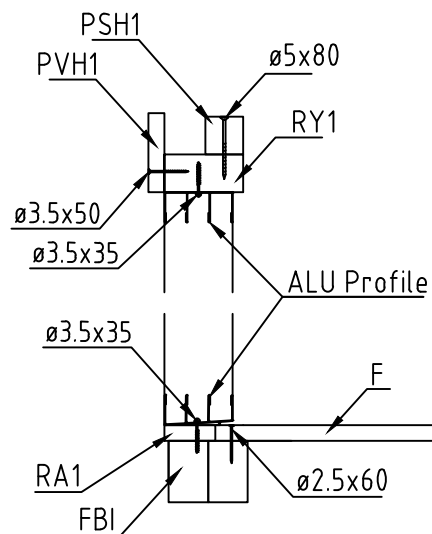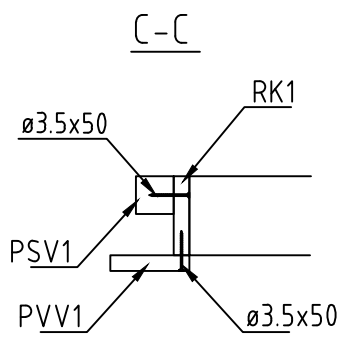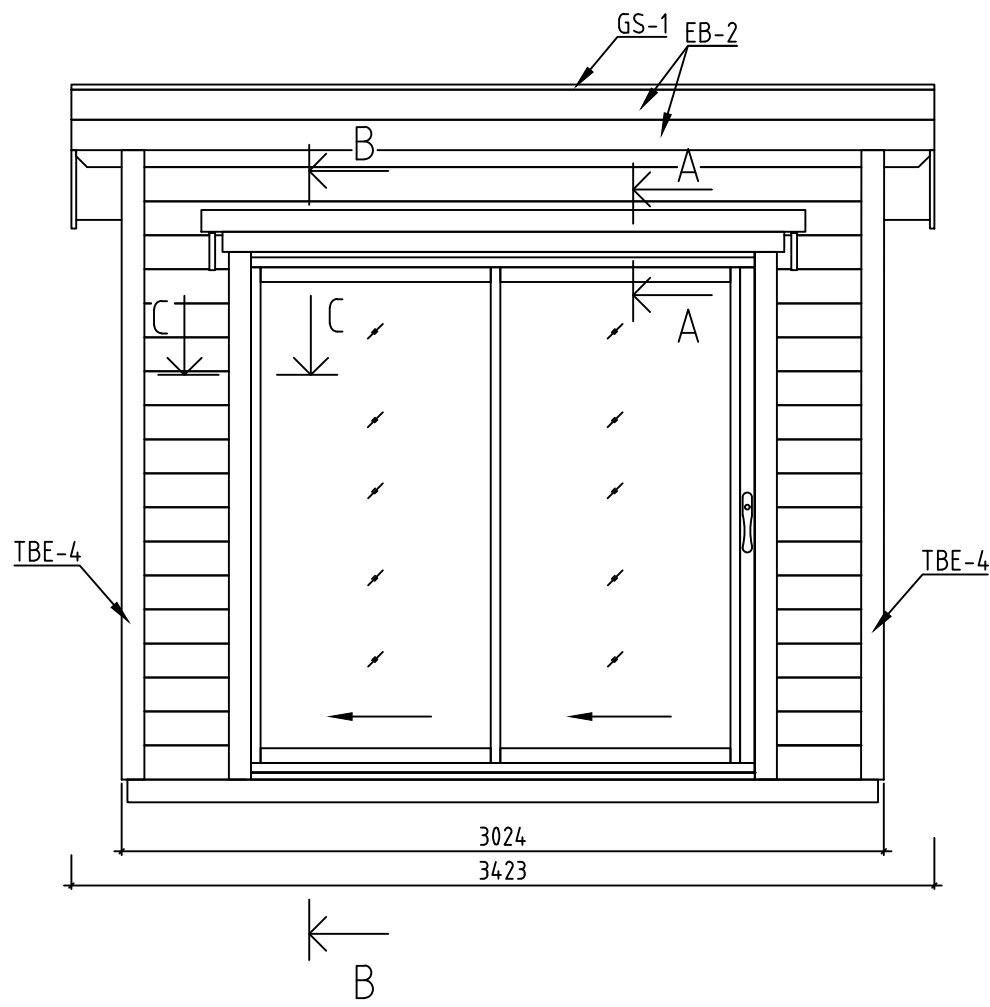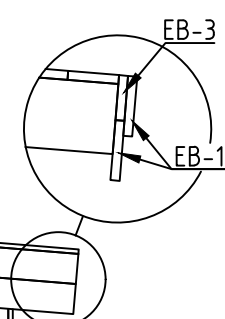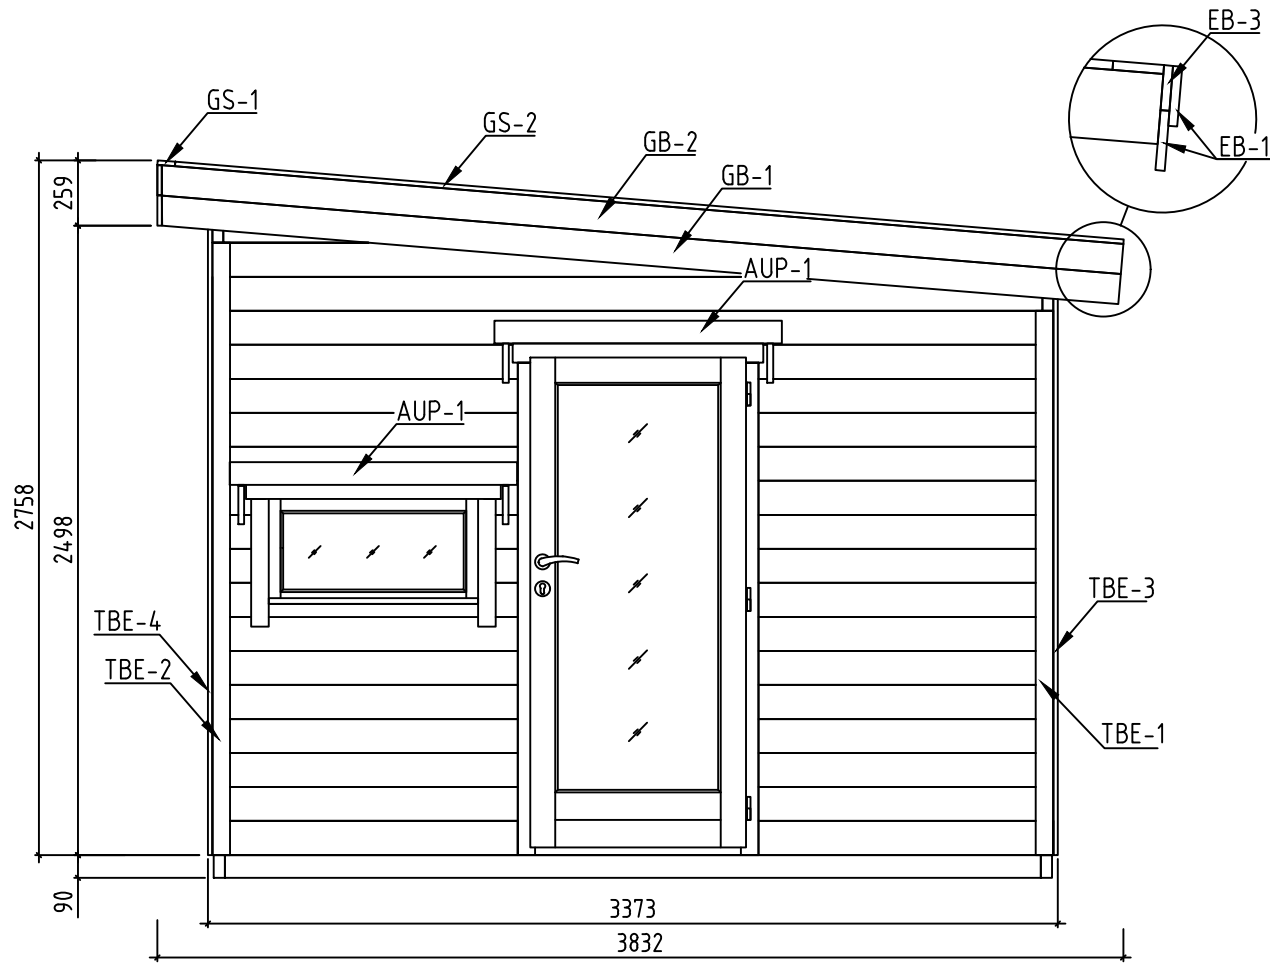


* Does not belong to the delivery set - Gehört nicht zum Lieferumfang - Pas inclus dans l'ensemble - Ingår inte i huspaketet


Name-Name-Nom-Titel 4457221	Page-Seite-Page-Sida 8
View-Aussicht-Vue-Utsikt GRUNDPLAN - GRUNDPLAN - PLAN DE MASSE - PLANRITNING	Scale-Maßstab-Echelle-Skala 1:30
Material-Material-Matériau-Material 44x135	Date-Datum-Date-Datum 26.04.2022
Drafter-Zeichner-Rédacteur-Föredragande EJ	

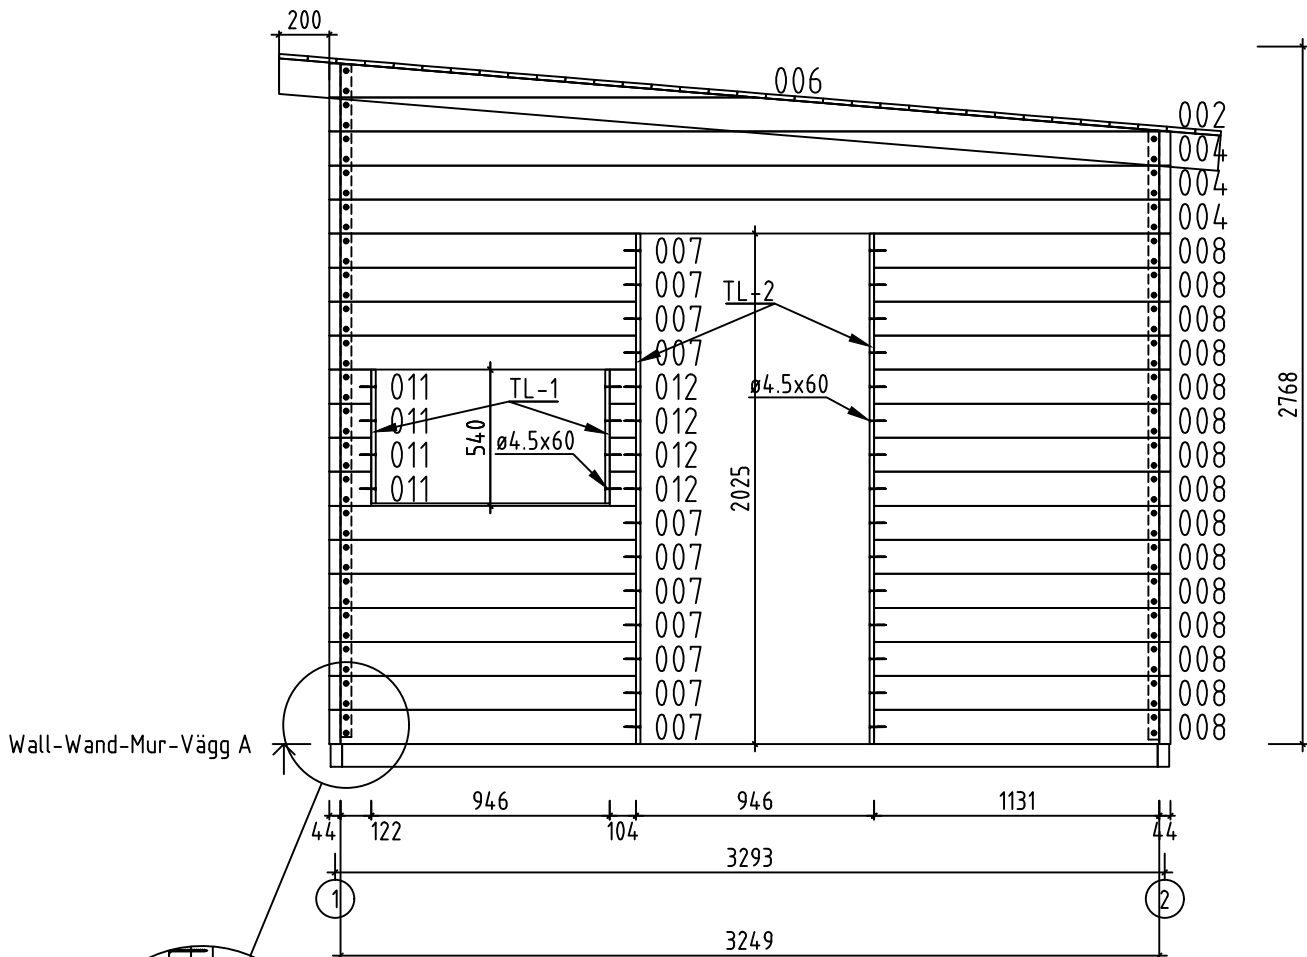



Wall-Wand-Mur-Vägg A

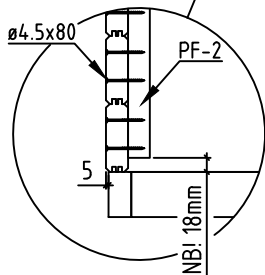


Name-Name-Nom-Titel 4457221	Page-Seite-Page-Sida 9
View-Aussicht-Vue-Utsikt Wall-Wand-Mur-Vägg A	
Material-Material-Matériel-Material 4.4x13.5	Scale-Maßstab-Echelle-Skala 1:30
Drafter-Zeichner-Rédacteur-Föredragande EJ	Date-Datum-Date-Datum 26.04.2022

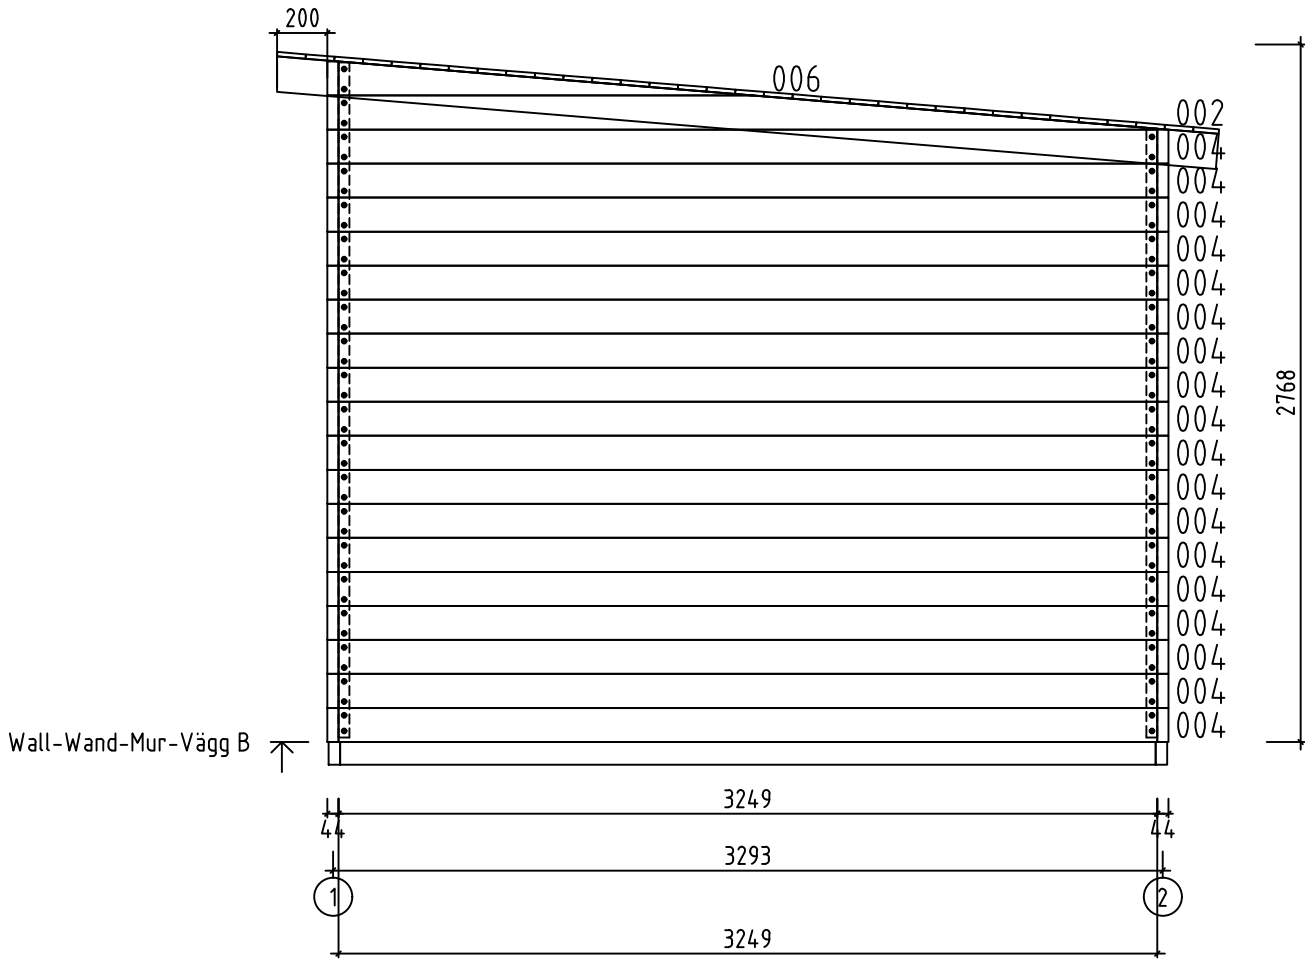

Name-Name-Nom-Titel 4457221	Page-Seite-Page-Sida 10
View-Aussicht-Vue-Utsikt Wall-Wand-Mur-Vägg B	
Material-Material-Matériel-Material 4.4x13.5	Scale-Maßstab-Echelle-Skala 1:30
Drafter-Zeichner-Rédacteur-Föredragande EJ	Date-Datum-Date-Datum 26.04.2022

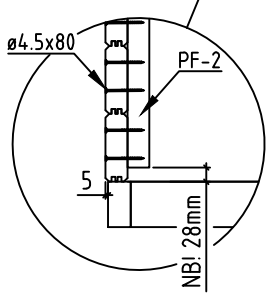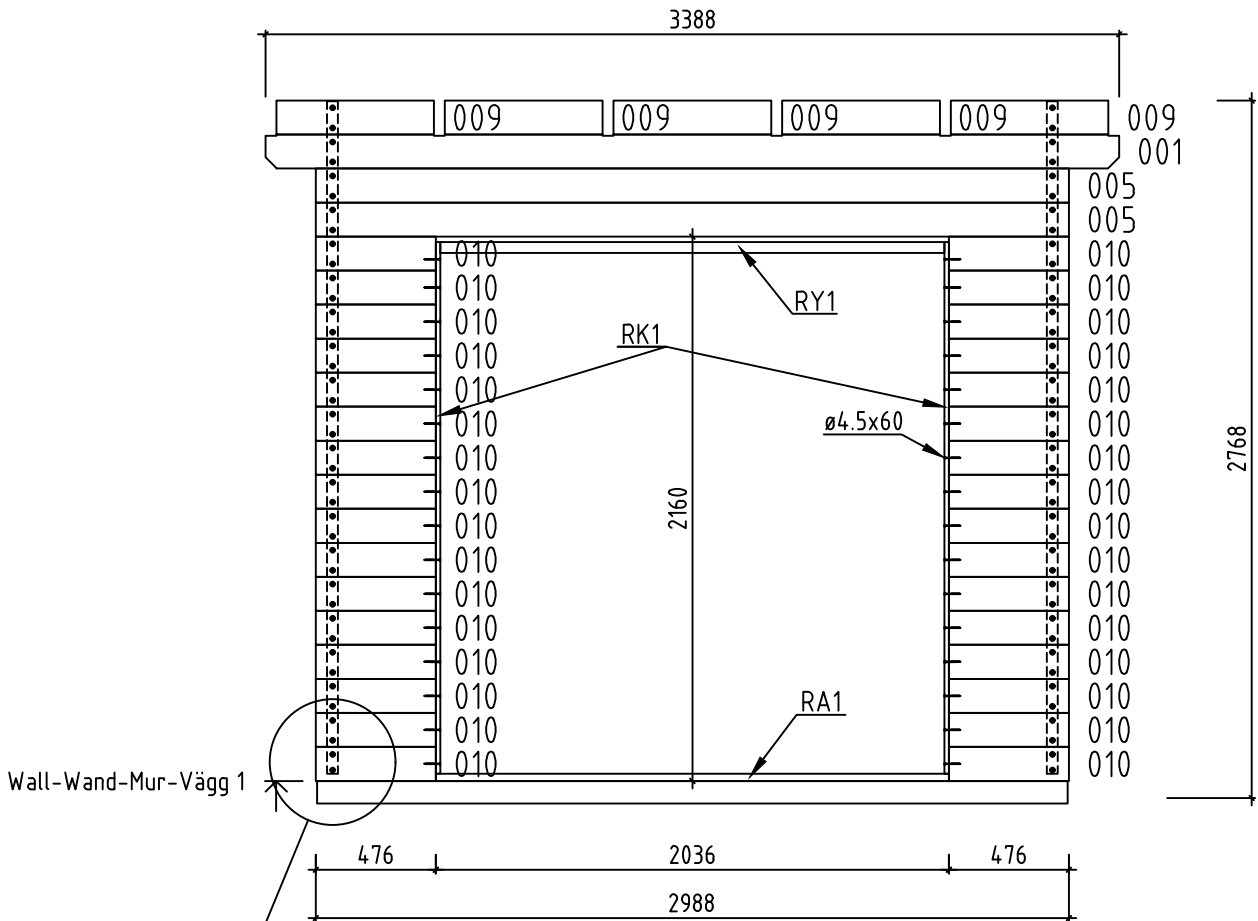

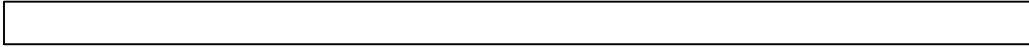



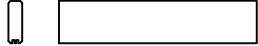
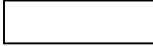
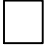
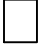
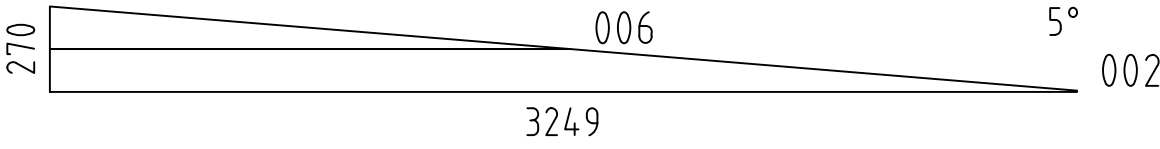
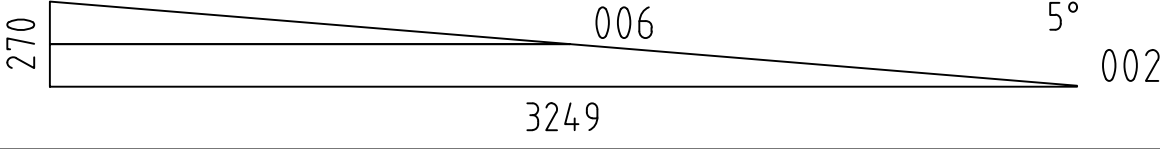
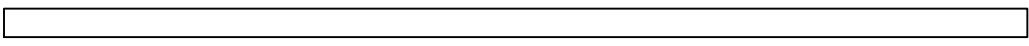
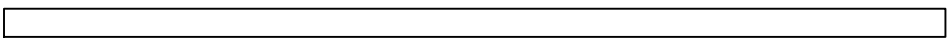

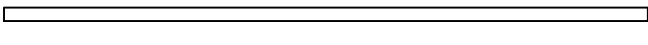
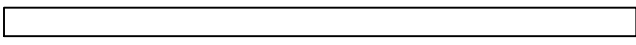
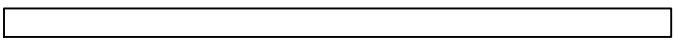
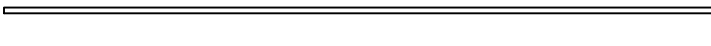
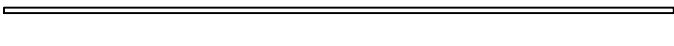
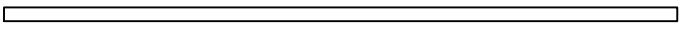
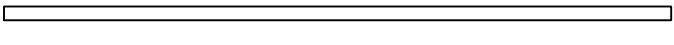
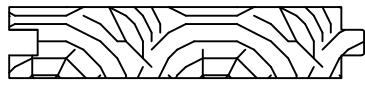
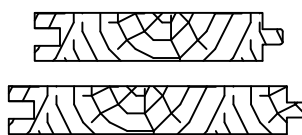


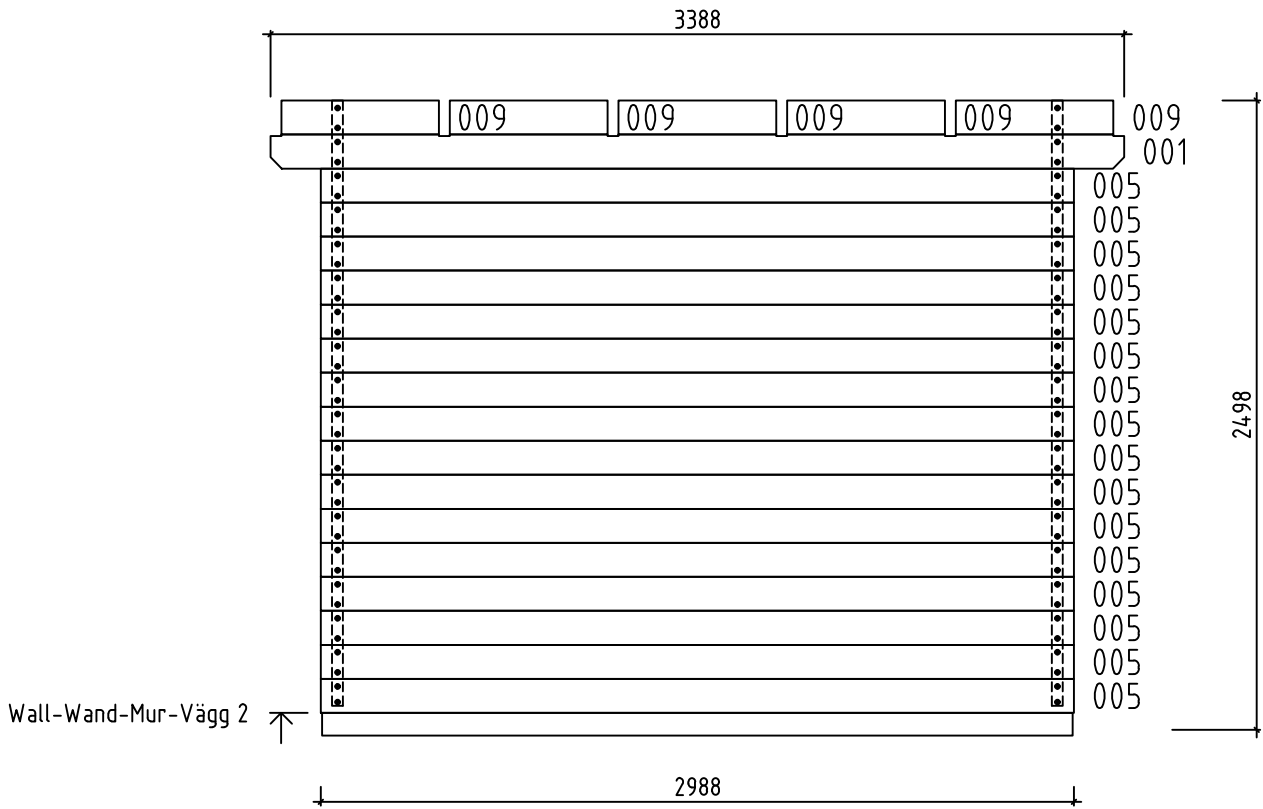
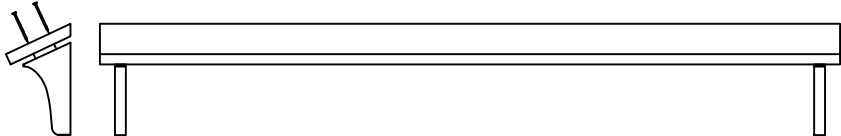
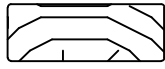

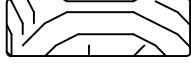
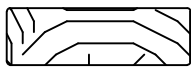







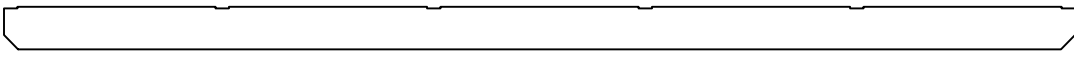


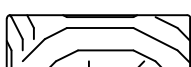






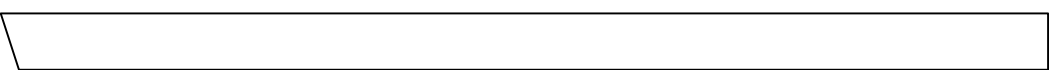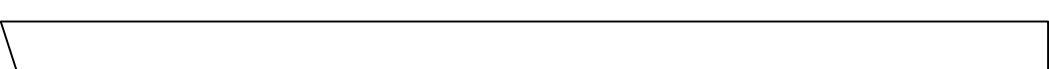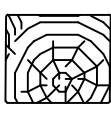

Name-Name-Nom-Titel 4457221	Page-Seite-Page-Sida 11
View-Aussicht-Vue-Utsikt Wall-Wand-Mur-Vägg 1	
Material-Material-Matériel-Material 4.4x13.5	Scale-Maßstab-Echelle-Skala 1:30
Drafter-Zeichner-Rédacteur-Föredragande EJ	Date-Datum-Date-Datum 26.04.2022






Wall-Wand-Mur-Vägg 2 ↗

Name-Name-Nom-Titel 4457221	Page-Seite-Page-Sida 12
View-Aussicht-Vue-Utsikt Wall-Wand-Mur-Vägg 2	
Material-Material-Matériel-Material 4.4x13.5	Scale-Maßstab-Echelle-Skala 1:30
Drafter-Zeichner-Rédacteur-Föredragande EJ	Date-Datum-Date-Datum 26.04.2022

Pos	4457221 Piece list - Stückliste - Liste des pieces - Delförteckning	Q.	P (mm)	L (mm)
001		2	44x135	3388
003	SPARE BEAM-ERZATZBOHLE-FAISCEAU DE RECHANGE-RESERVDEL 	1	44x135	3249
004		21	44x135	3249
005		18	44x135	2988
007		11	44x135	1172
008		15	44x135	1131
009		10	44x135	626
010		32	44x135	476
011		4	44x135	122
012		4	44x135	104
WA-1		1		
WB-1		1		
FBI1	FOUNDATION - FUNDAMENT - FONDATION - GOLVBJÄLKAR 	8	45x90	3237
FBI2	FOUNDATION - FUNDAMENT - FONDATION - GOLVBJÄLKAR 	2	45x90	2978
FR1	RAFTER - DACHSPARREN - CHEVRON - TAKBJÄLKE 	6	43x140	3750
RA1	COVERING MOULDING - DECKUNGSPROFIL - PROFILS DE FINITION - MONTERINGSBRÄDA 	1	28x43	2036
RY1	COVERING MOULDING - DECKUNGSPROFIL - PROFILS DE FINITION - MONTERINGSBRÄDA 	1	43x90	2000
RK1	COVERING MOULDING - DECKUNGSPROFIL - PROFILS DE FINITION - MONTERINGSBRÄDA 	2	18x90	2110
PVH1	COVERING MOULDING - DECKUNGSPROFIL - PROFILS DE FINITION - MONTERINGSBRÄDA 	1	90x18	2240
PVV1	COVERING MOULDING - DECKUNGSPROFIL - PROFILS DE FINITION - MONTERINGSBRÄDA 	2	90x18	2118
PSH1	COVERING MOULDING - DECKUNGSPROFIL - PROFILS DE FINITION - MONTERINGSBRÄDA 	1	43x43	2130
PSV1	COVERING MOULDING - DECKUNGSPROFIL - PROFILS DE FINITION - MONTERINGSBRÄDA 	2	43x43	2110
F-1	FLOOR BOARDS-FUSSBODENBRETTER-LAME DE PLANCHER-GOLVBRÄDOR 	29+1	114x28	2894
R-1	ROOF BOARDS - DACHBRETTER - VOLIGES - TAKBRÄDE  or-oder-ou-eller	43+1 33+1	88x18 114x18	3388
FF-1	FLOOR FILLET-FUSSBODENLEISTE - CORNIERE DE FINITION DU PLANCHER - GOLVLÄKT 		18x35	13 m.

Pos	4457221 Piece list - Stückliste - Liste des pieces - Delförteckning		Q.	P (mm)	L (mm)
AUP-1	WEATHER BOARD - REGENABSCHLUSSBRETT - ABILLAGE - HYLLBRÄDA		2	18x120	1140
AUP-2	WEATHER BOARD - REGENABSCHLUSSBRETT - ABILLAGE - HYLLBRÄDA		1	18x120	2240
TL-1	FIXING FILLET - FIXIRUNGSLEISTE - PROFIL DE FIXATION - MONTERINGSLIST		2	18x44	530
TL-2	FIXING FILLET - FIXIRUNGSLEISTE - PROFIL DE FIXATION - MONTERINGSLIST		2	18x44	2025
TBE-1	COVERING BOARD - DECKENLEISTEN - PROFILS DE FINITION - TÄCKBRÄDA		2	18x70	2165
TBE-2	COVERING BOARD - DECKENLEISTEN - PROFILS DE FINITION - TÄCKBRÄDA		2	18x70	2435
TBE-3	COVERING BOARD - DECKENLEISTEN - PROFILS DE FINITION - TÄCKBRÄDA		2	18x90	2435
TBE-4	COVERING BOARD - DECKENLEISTEN - PROFILS DE FINITION - TÄCKBRÄDA		2	18x90	2710
GB-1	GABLE MOULDING - GIBELLEISTE - PLANCHE DE RIVE - VINDBRÄDE		2	18x120	3820
GB-2	GABLE MOULDING - GIBELLEISTE - PLANCHE DE RIVE - VINDBRÄDE		2	18x120	3830
PF-1	CORNER STUD - ECKPFOSTEN - POTEAUX POUR PREAU - HÖRNLÄKT		2	43x43	2405
PF-2	CORNER STUD - ECKPFOSTEN - POTEAUX POUR PREAU - HÖRNLÄKT		2	43x43	2670
EB-1	EAVES BOARD - TRAUFBRETT - BANDEAU DE TOIT - TAKFOTSINKLÄDNAD		2	18x120	3388
EB-2	EAVES BOARD - TRAUFBRETT - BANDEAU DE TOIT - TAKFOTSINKLÄDNAD		2	18x120	3425
EB-3	EAVES BOARD - TRAUFBRETT - BANDEAU DE TOIT - TAKFOTSINKLÄDNAD		1	18x90	3388
GS-1	ROOFING FELT FILLET - DACHPAPPENLEISTE - BAGUETTE DE FIXATION DU FEUTRE BITUMEUX - BRÄDA OVANPÅ GAVELBRÄDA		1	18x70	3425
GS-2	ROOFING FELT FILLET - DACHPAPPENLEISTE - BAGUETTE DE FIXATION DU FEUTRE BITUMEUX - BRÄDA OVANPÅ GAVELBRÄDA		2	18x70	3778
HS	SCREW FOR COVERING BOARD - SCHRAUBE FÜR DECKENLEISTEN - VIS POUR PROFILS DE FINITION - SKRUV FÖR TÄCKBRÄDA (KLS)		48	ø4.5x50	
HS	SCREW FOR DOOR JAMB - SCHRAUBE FÜR TÜRRAHMEN - VIS DE FIXATION POUR MONTANT DE PORTE - SKRUV TILL DÖRRKARMAR		12	ø4.5x50	
HS	SCREW FOR GABLE MOULDING - SCHRAUBE FÜR GIBELLEISTE - VIS DE FIXATION POUR PLANCHE DE RIVE - SKRUV FÖR GAVELBRÄDA (GB)		28	ø4.5x50	
HS	SCREW FOR COVERING MOULDING - SCHRAUBE FÜR DECKUNGSPROFIL - VIS DE FIXATION POUR PROFILS DE FINITION - SKRUV FÖR TÄCKLIST		18	ø4.5x50	
HS	SCREW FOR EAVES BOARDS (EB) - SCHRAUBE FÜR TRAUFBRETT (EB) - VIS DE FIXATION POUR BANDEAU DE TOIT (EB) - SKRUV FÖR GAVELBRÄDOR (EB)		50	ø4.5x50	
HS	SCREW FOR WEATHER BOARD - SCHRAUBE FÜR REGENABSCHLUSSBRETT - VIS POUR HABILLAGE - SKRUV FÖR HYLLBRÄDA (AUP)		26	ø4.5x50	
HS	SCREW FOR ROOFING FELT FILLET - SCHRAUBE FÜR DACHPAPPEN- LEISTE - VIS POUR BAGUETTE FIXATION FEUTRE BITUMEUX - SKRUV FÖR TAKLÄKT (GS)		26	ø4.5x50	
HS	SCREW FOR FIXING FILLET - SCHRAUBE FÜR FIXIRUNGSLEISTE - VIS POUR FIXATION PROFIL - SKRUV FÖR MONTERINGSLIST (TL)		70	ø4.5x60	

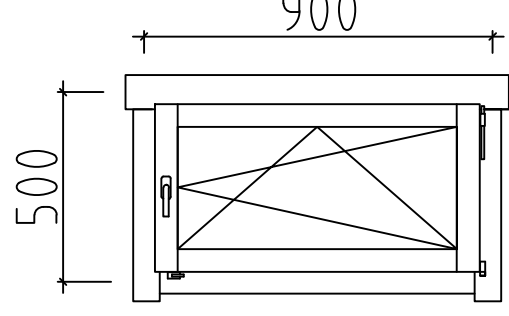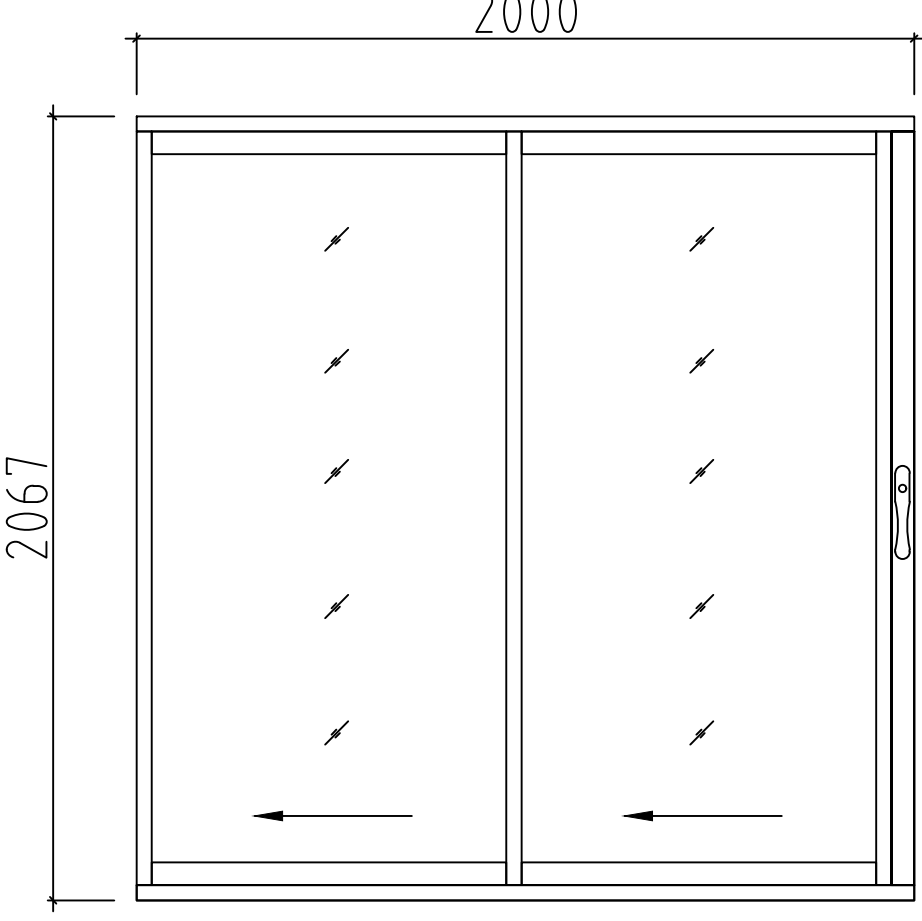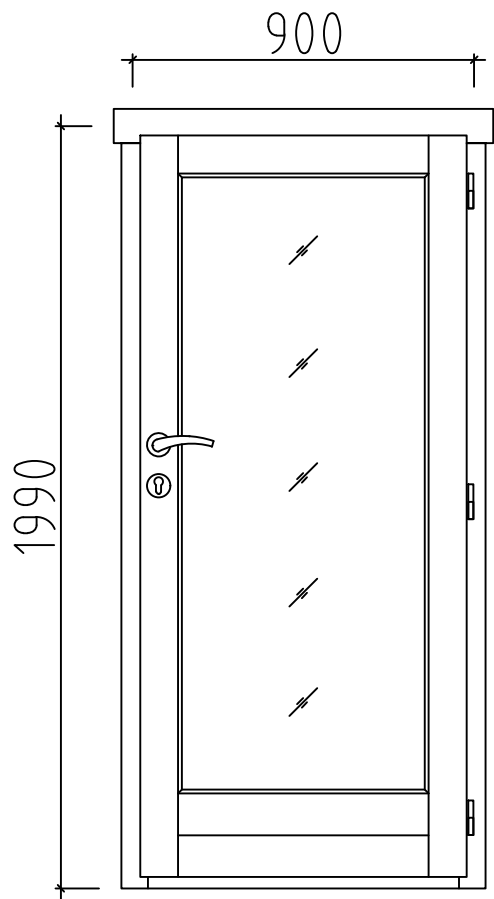Pos	4457221 Piece list - Stückliste - Liste des pieces	Q.	P (mm)	L (mm)
	WINDOW-FENSTER-FENETRE-FÖNSTER, AST PRE 	R	1	900x500
	DOOR-TÜR-PORTE-DÖRR, ALU, ISO 	L	1	2000x2067
	DOOR-TÜR-PORTE-DÖRR, PRE 	R	1	900x1990